

ARCHITECTURAL DRAWING LIST



SL. NO.	DRAWING TITLE	DRAWING NUMBER	SHEET	REVISION
1.	CONTROL BUILDING – ARCHITECTURAL FLOOR PLANS	18A08-DWG-A-T0001	4	0
2.	CONTROL BUILDING – ARCHITECTURAL ELEVATIONS & SECTIONS	18A08-DWG-A-T0002	1	0
3.	CONTROL BUILDING – ARCHITECTURAL FINISH SCHEDULE	18A08-DWG-A-T0003	1	0
4.	CONTROL BUILDING – DOOR, WINDOW, RS SCHEDULE	18A08-DWG-A-T0004	2	0

TENDER PURPOSE ONLY

	OWNER: IFFCO PARADEEP
PROJECT: IFFCO PARADEEP AFBC BOILER CONTROL ROOM	
TITLE: LIST OF DETAIL ENGINEERING DRAWINGS ARCHITECTURAL	

DEVELOPMENT CONSULTANTS PVT LTD. CONSULTING ENGINEERS KOLKATA • MUMBAI • CHENNAI • NEW DELHI														
<table style="width: 100%;"> <tr><td>PREPARED</td><td>SM</td><td>JOB NO.</td><td>18A08</td></tr> <tr><td>CHECKED</td><td>SA</td><td>SCALE</td><td>NTS</td></tr> <tr><td>APPROVED</td><td>PKP</td><td>DATE</td><td>22.11.2019</td></tr> </table>	PREPARED	SM	JOB NO.	18A08	CHECKED	SA	SCALE	NTS	APPROVED	PKP	DATE	22.11.2019		REV 0 1 SHEET OF 1
PREPARED	SM	JOB NO.	18A08											
CHECKED	SA	SCALE	NTS											
APPROVED	PKP	DATE	22.11.2019											
DWG. NO. 18A08-DWG-A-T0000		162												

APPROV.	MECH.	INST.	ELEC.	STRL.	ARCH.	NATURE OF REVISION & DESCRIPTION	CHECKED	DRAWN	REV.	DATE	RELEASE STATUS	DATE	SIGNATURE

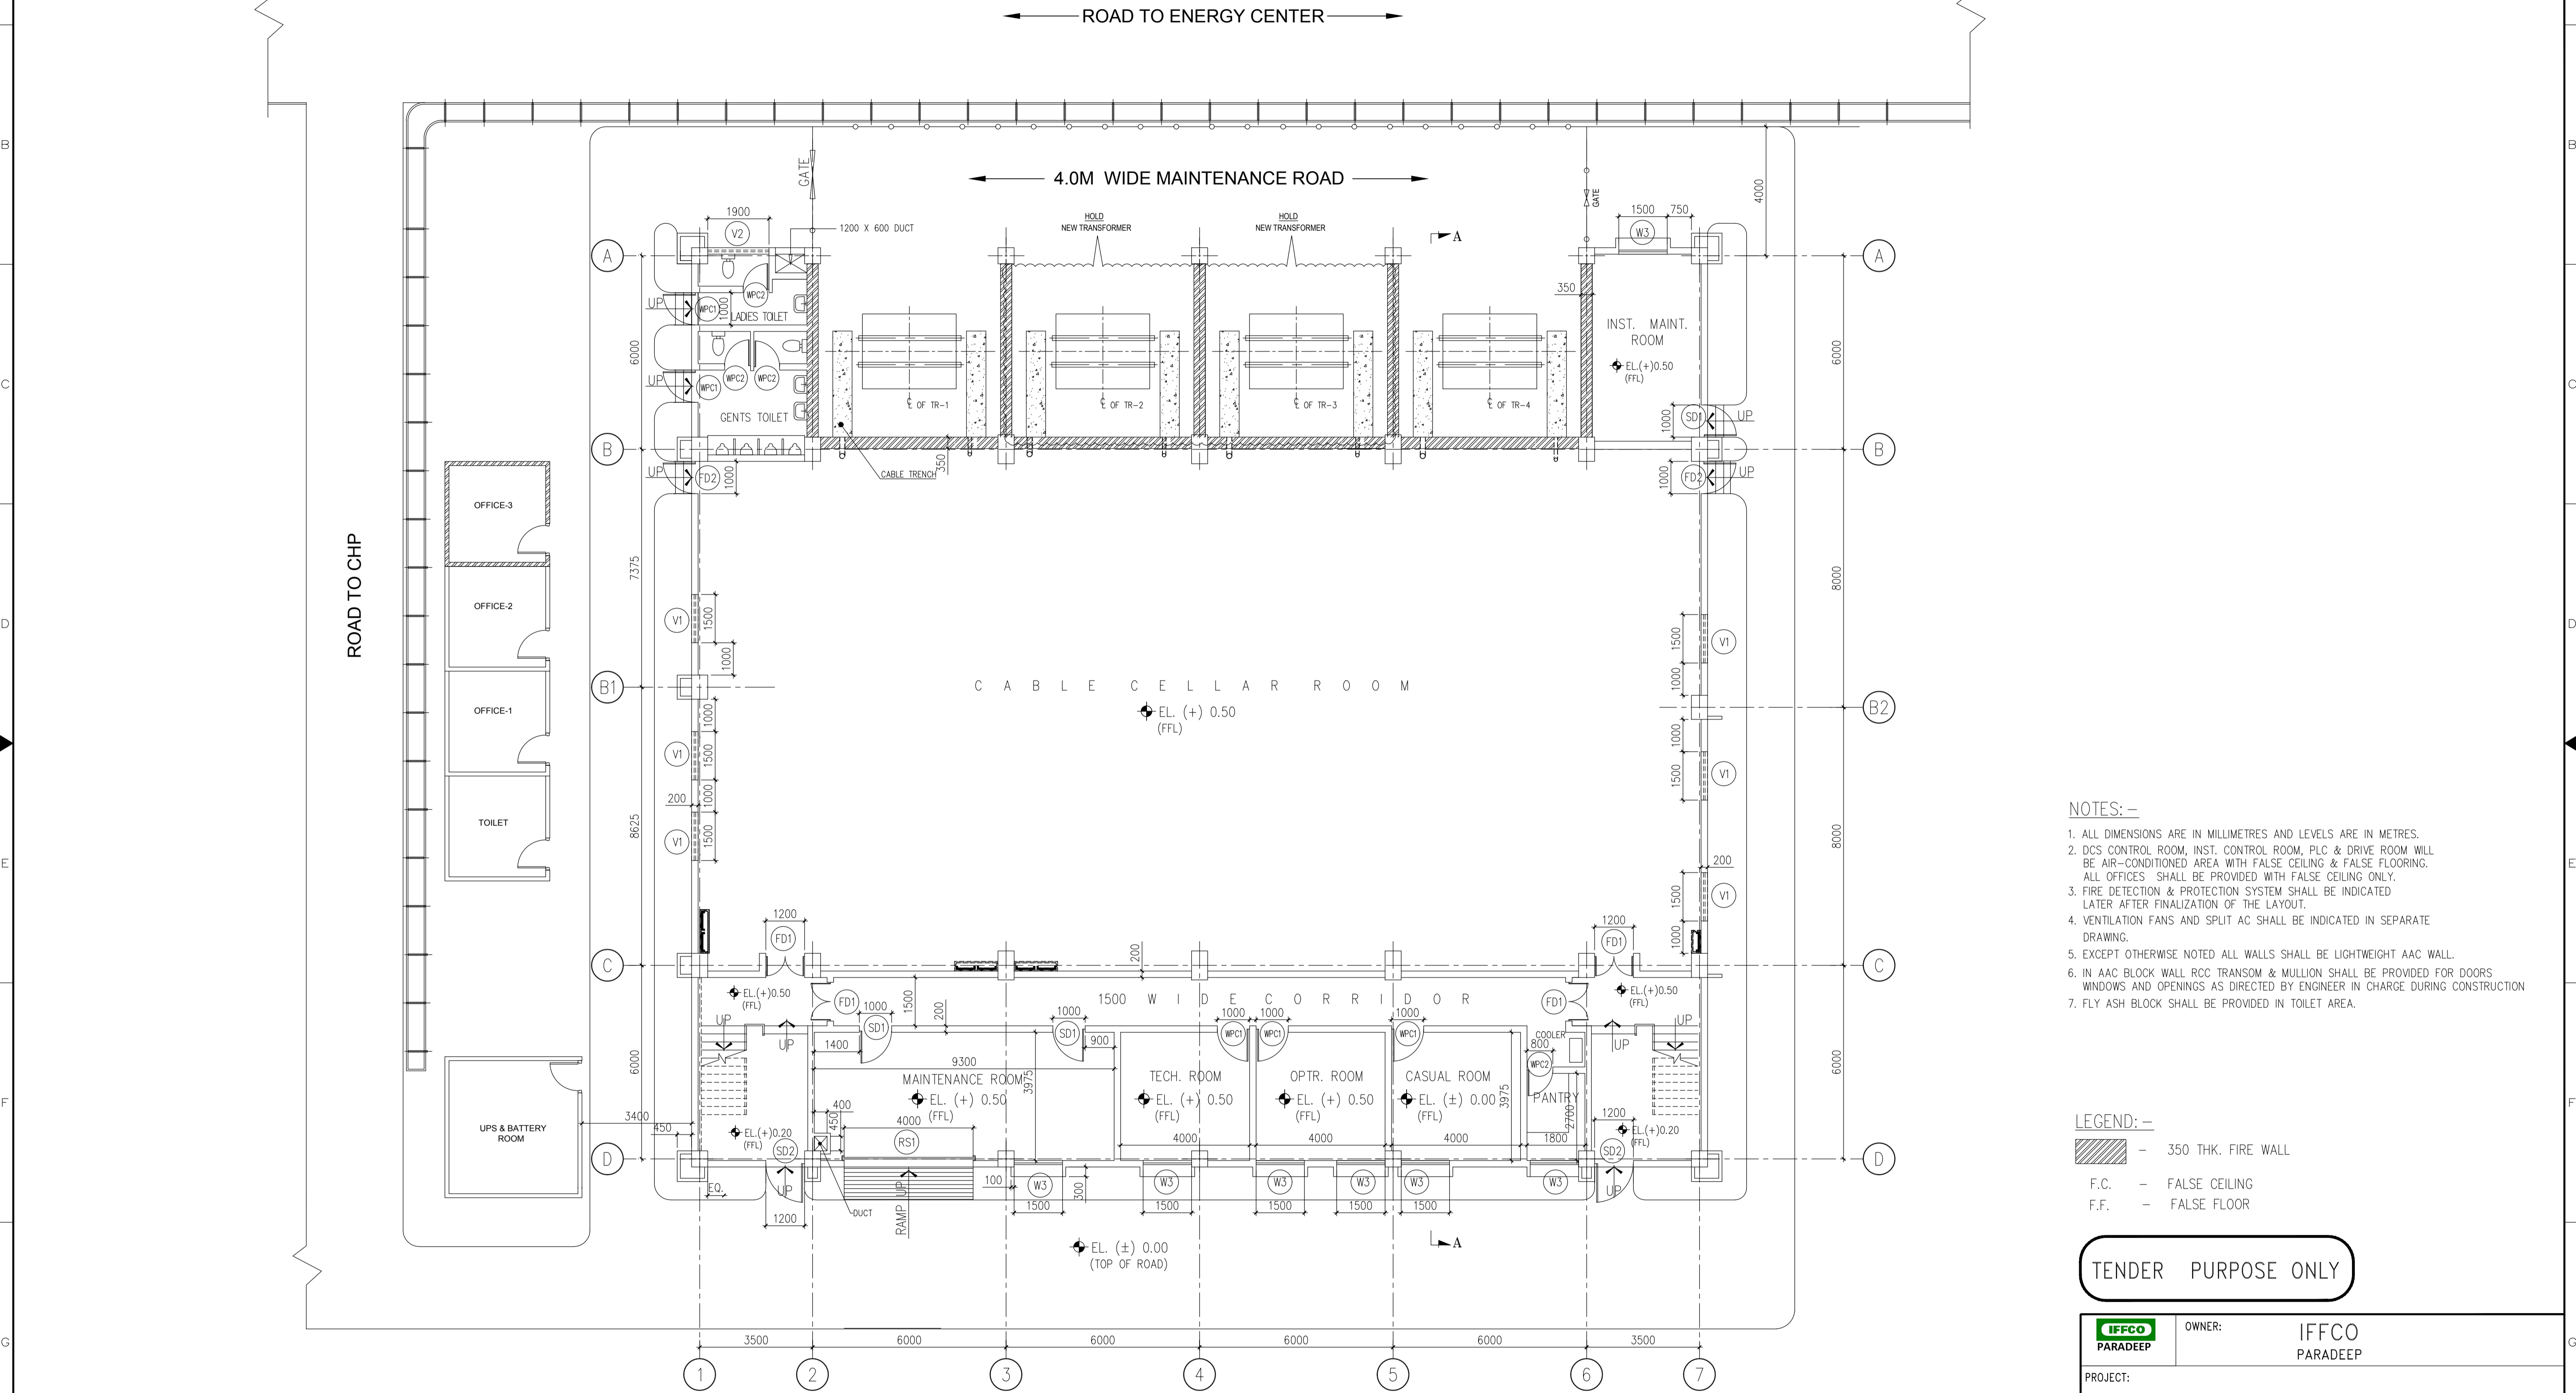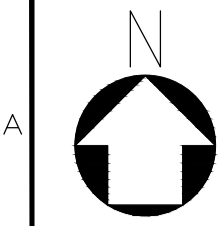

GROUND FLOOR PLAN
EL. (+) 0.50

NOTES: -

1. ALL DIMENSIONS ARE IN MILLIMETRES AND LEVELS ARE IN METRES.
2. DCS CONTROL ROOM, INST. CONTROL ROOM, PLC & DRIVE ROOM WILL BE AIR-CONDITIONED AREA WITH FALSE CEILING & FALSE FLOORING. ALL OFFICES SHALL BE PROVIDED WITH FALSE CEILING ONLY.
3. FIRE DETECTION & PROTECTION SYSTEM SHALL BE INDICATED LATER AFTER FINALIZATION OF THE LAYOUT.
4. VENTILATION FANS AND SPLIT AC SHALL BE INDICATED IN SEPARATE DRAWING.
5. EXCEPT OTHERWISE NOTED ALL WALLS SHALL BE LIGHTWEIGHT AAC WALL.
6. IN AAC BLOCK WALL RCC TRANSOM & MULLION SHALL BE PROVIDED FOR DOORS WINDOWS AND OPENINGS AS DIRECTED BY ENGINEER IN CHARGE DURING CONSTRUCTION
7. FLY ASH BLOCK SHALL BE PROVIDED IN TOILET AREA.

LEGEND: -

- 350 THK. FIRE WALL
- F.C. - FALSE CEILING
- F.F. - FALSE FLOOR

TENDER PURPOSE ONLY

	OWNER: IFFCO PARADEEP
PROJECT:	IFFCO PARADEEP AFBC BOILER CONTROL ROOM
TITLE:	CONTROL BUILDING GROUND FLOOR PLAN

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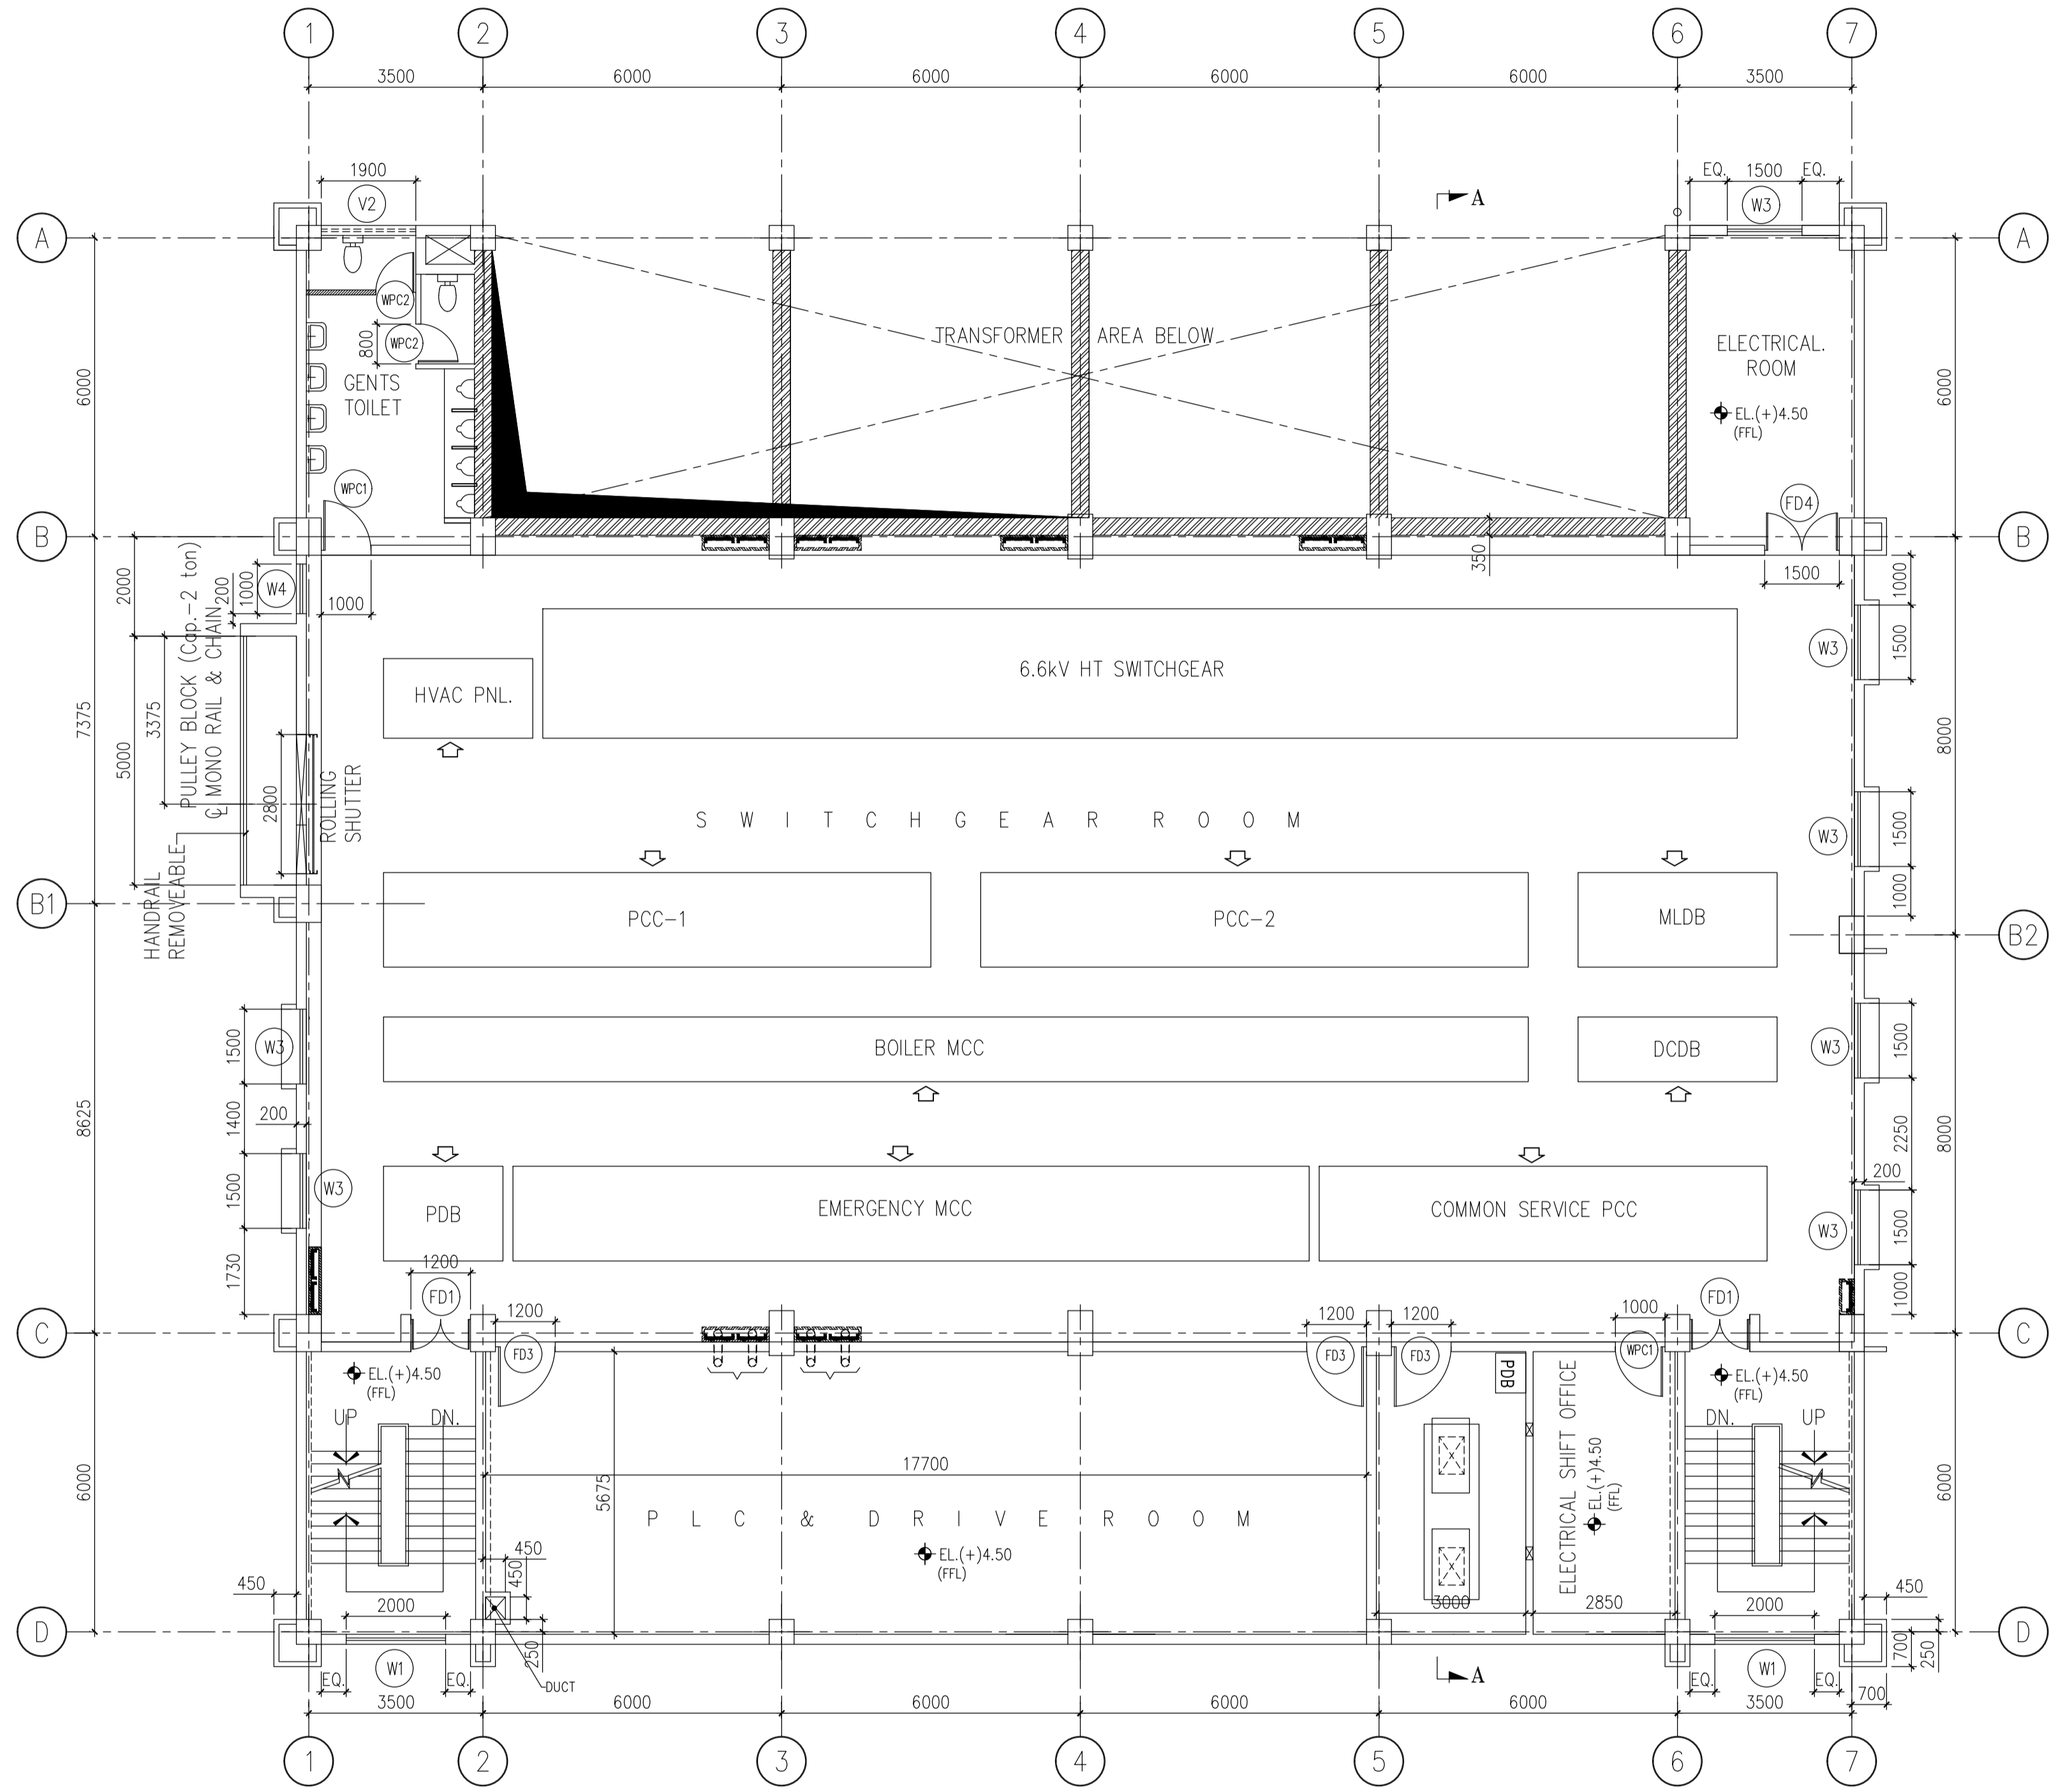
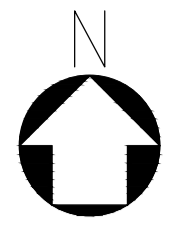
RELEASE STATUS	DATE	SIGNATURE
PRELIMINARY		
FOR TENDER ONLY	29.11.19	PKP
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ARCHITECTURAL	29.11.19	PKP
CIVIL & STRUCTURAL		
ELECTRICAL		
INSTRUMENTATION		
MECHANICAL		

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APPROVED	PKP	DATE	22.11.2019

DWG. NO. 18A08-DWG-A-T0001

REV 0
1 SHEET OF 4



FIRST FLOOR PLAN
EL. (+) 4.50 (FFL)

NOTES: -
1. FOR NOTES SEE THE DRAWING NUMBER 18A08-DWG-A-0002 SH-1

LEGEND: -
 - 350 THK. FIRE WALL
 F.C. - FALSE CEILING
 F.F. - FALSE FLOOR



TENDER PURPOSE ONLY

	OWNER: IFFCO PARADEEP
PROJECT:	IFFCO PARADEEP AFBC BOILER CONTROL ROOM
TITLE:	CONTROL BUILDING FIRST FLOOR PLAN

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DWG. NO. 18A08-DWG-A-T0001	REV 0 2 SHEET OF 4	

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MECHANICAL		

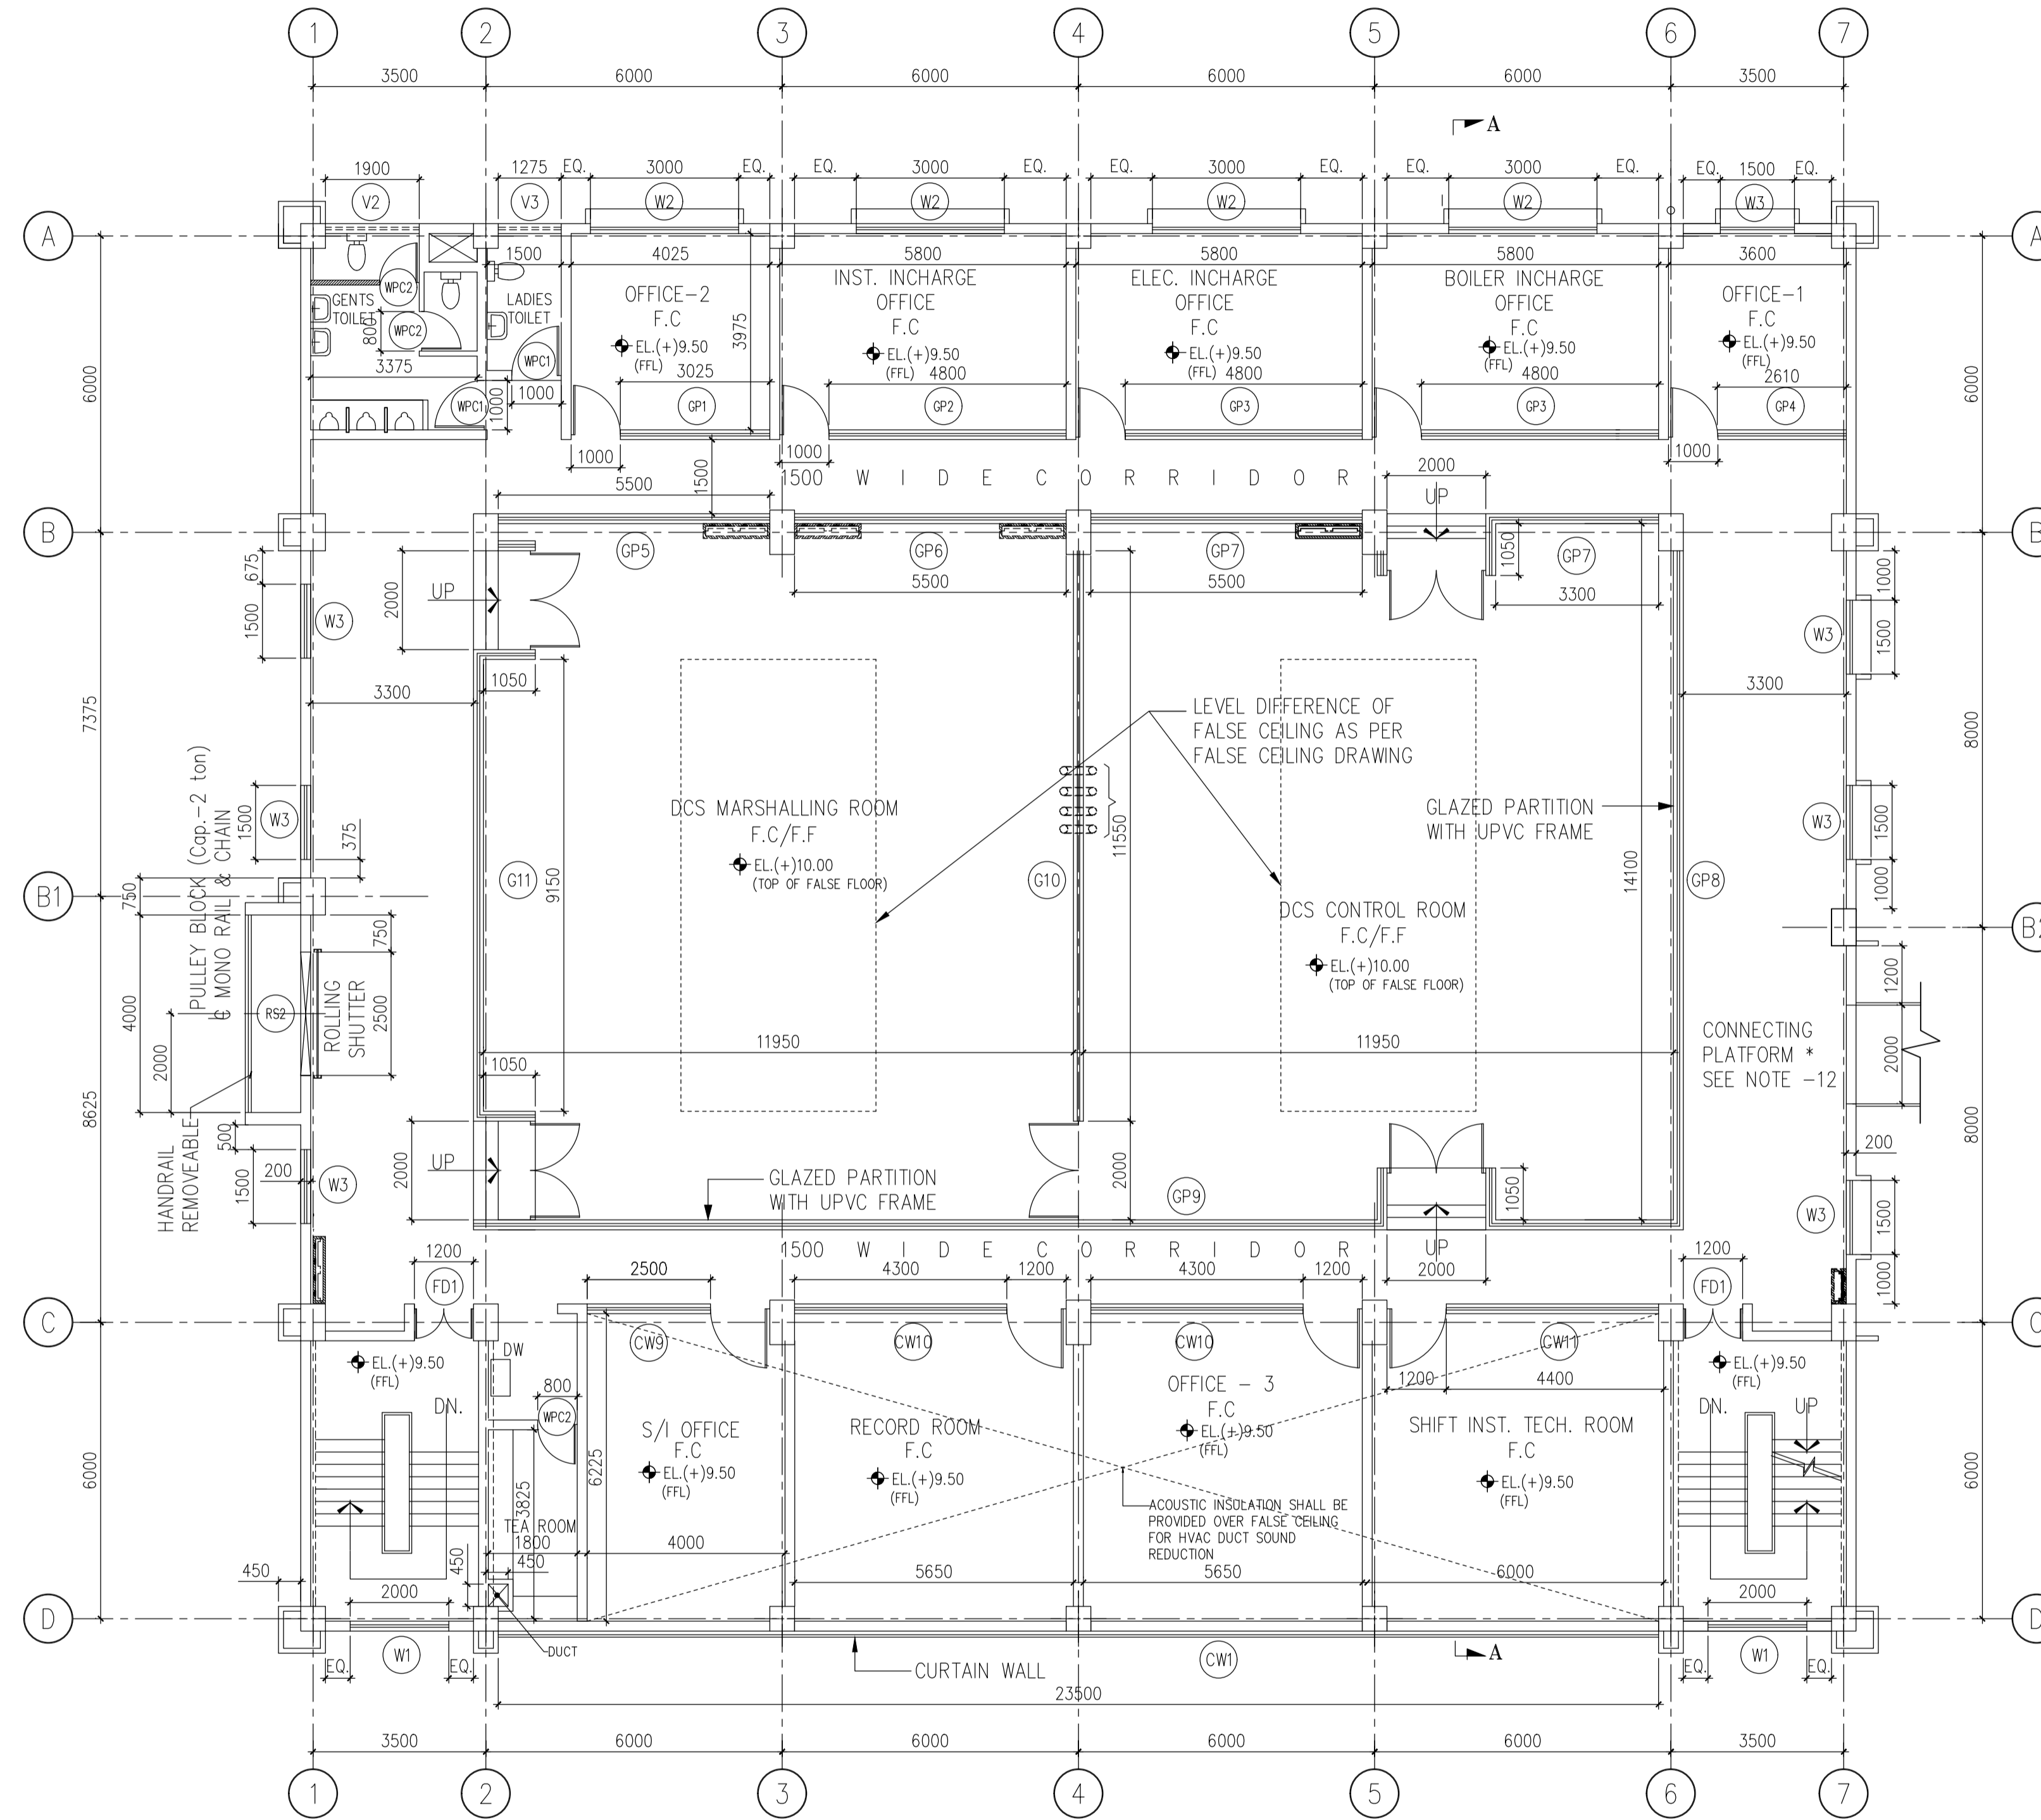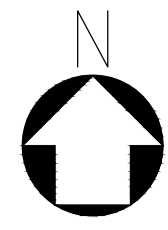

SECOND FLOOR PLAN
EL. (+) 9.50 (FFL)

NOTES: -

1. FOR NOTES SEE THE DRAWING NUMBER 18A08-DWG-A-0002 SH-1

LEGEND: -

F.C. - FALSE CEILING
F.F. - FALSE FLOOR

TENDER PURPOSE ONLY

IFFCO PARADEEP	OWNER: IFFCO PARADEEP
PROJECT: IFFCO PARADEEP AFBC BOILER CONTROL ROOM	
TITLE: CONTROL BUILDING SECOND FLOOR PLAN	

APPROV.	MECH.	INST.	ELEC.	STRL.	ARCH.	NATURE OF REVISION & DESCRIPTION	CHECKED	DRAWN	REV.	DATE	RELEASE STATUS	DATE	SIGNATURE
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											FOR CONSTRUCTION		
											ARCHITECTURAL	29.11.19	PKP
											CIVIL & STRUCTURAL		
											ELECTRICAL		
											INSTRUMENTATION		
											MECHANICAL		




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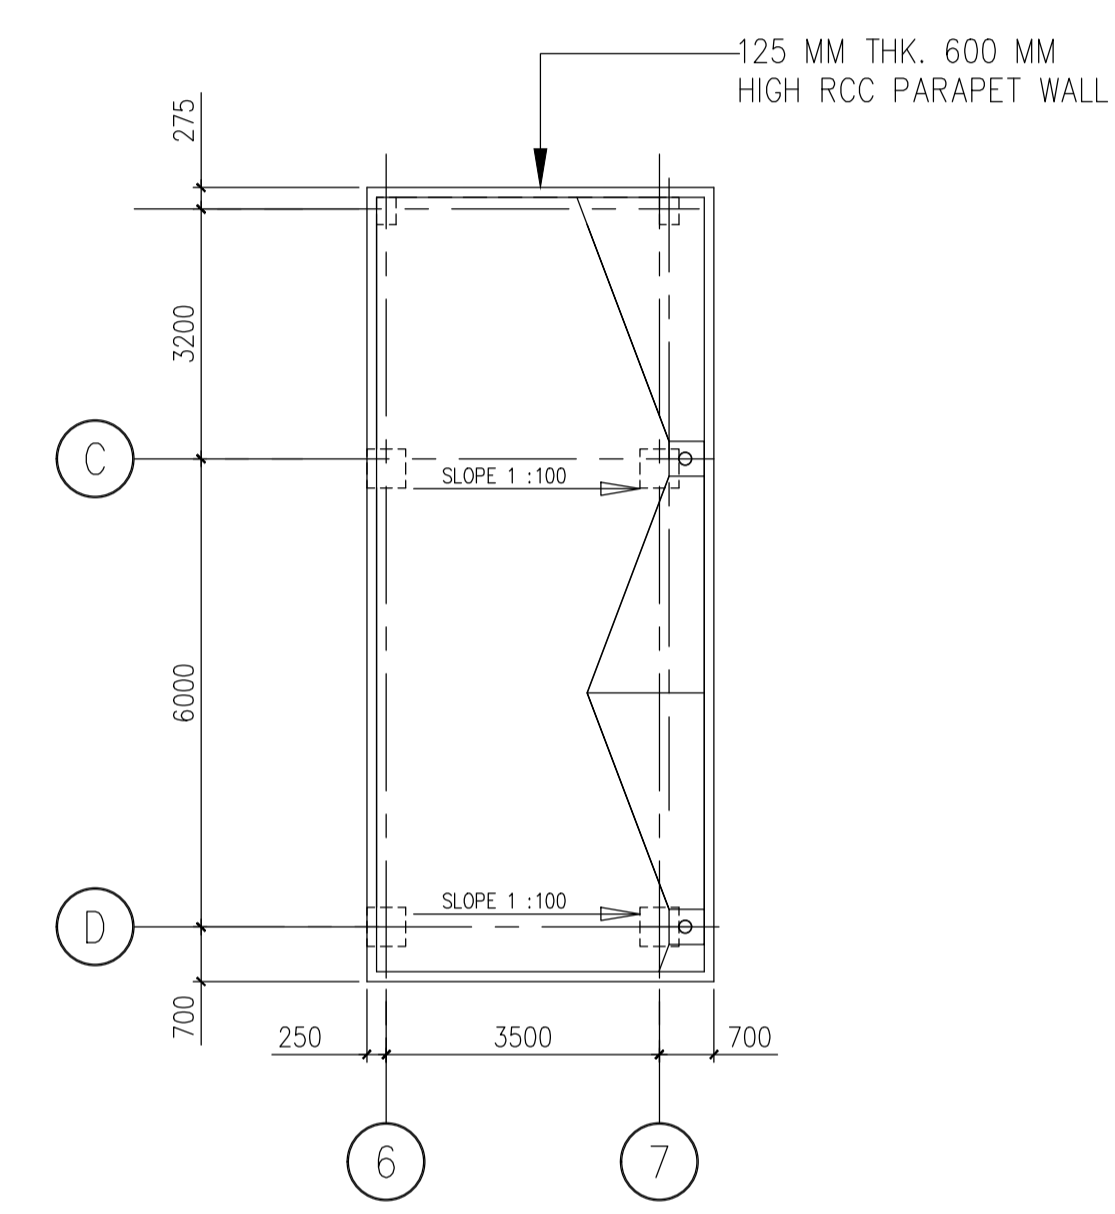
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DATE 22.11.2019

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REV 0
3 SHEET OF 4



ROOF PLAN (PART)
EL.(+)^{19.950M} (T.O.C.)

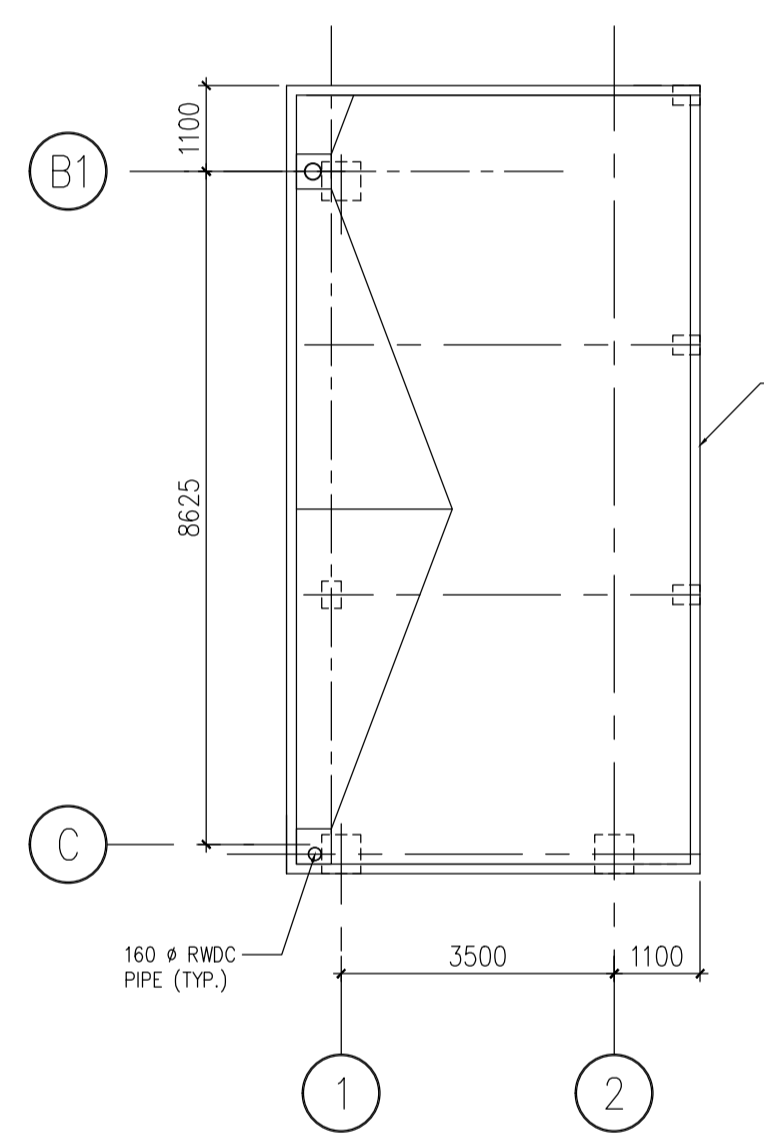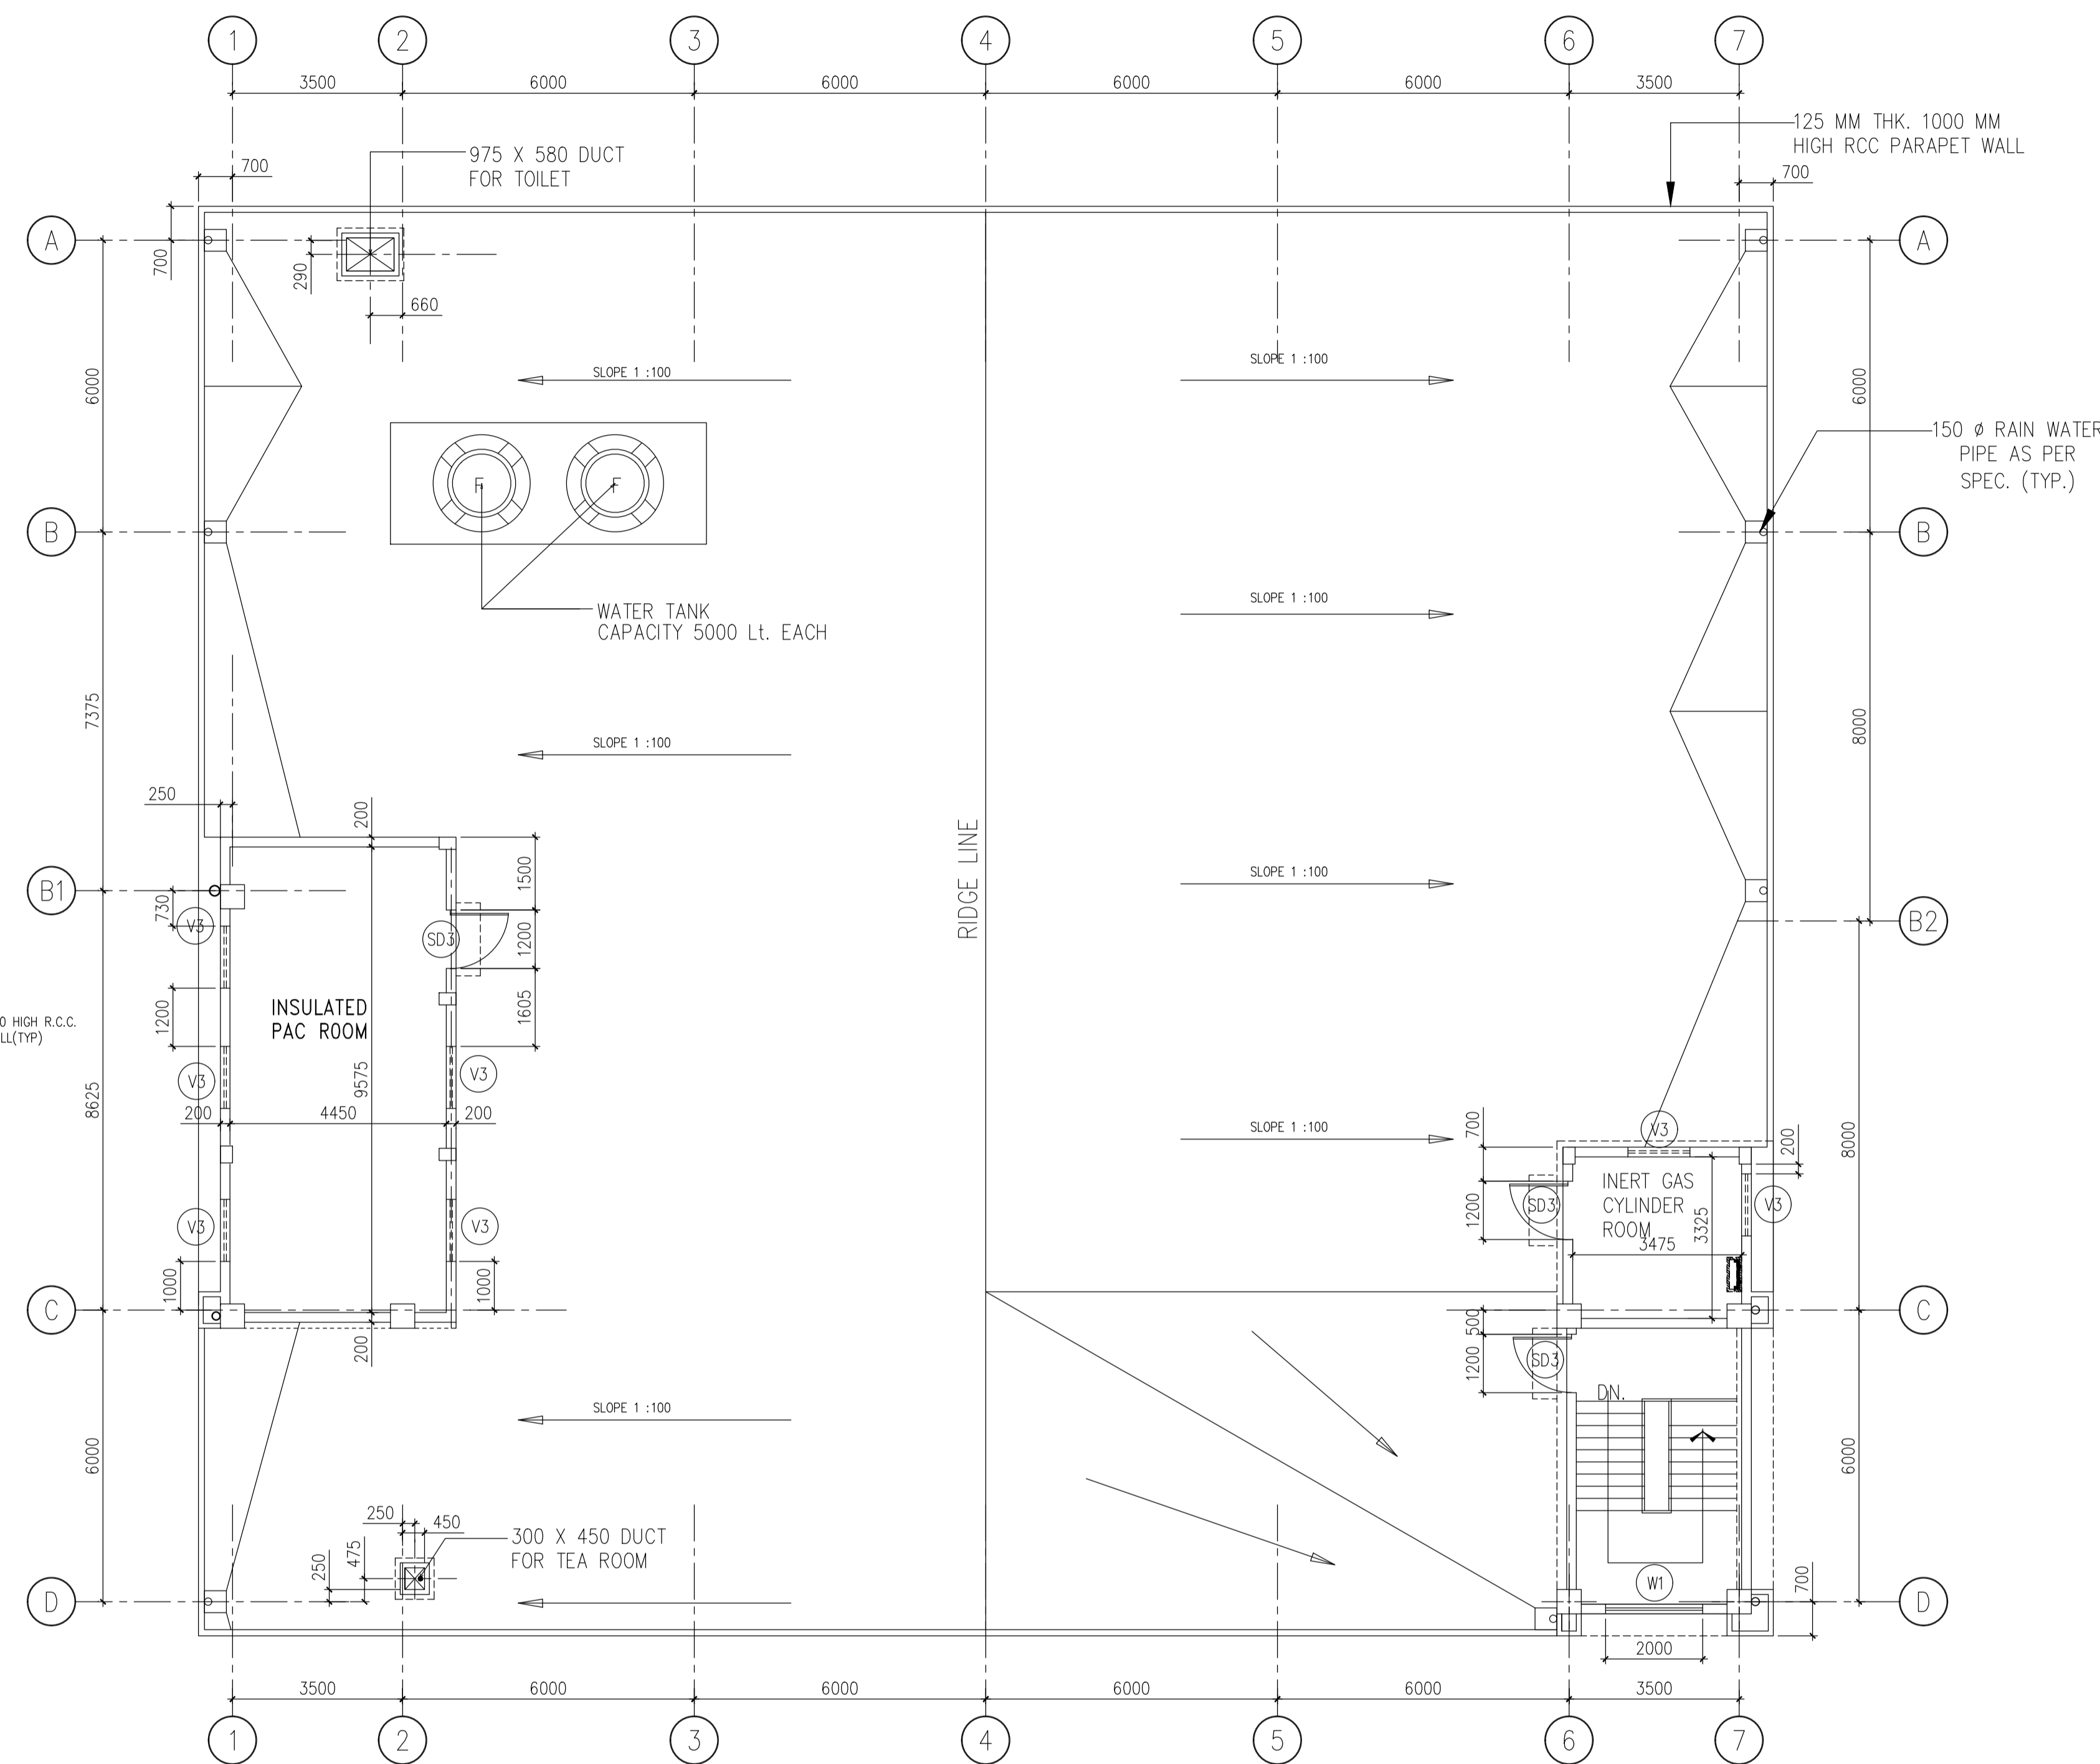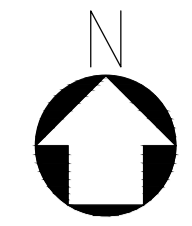

ROOF PLAN (PART)
EL.(+)^{17.950M}(T.O.C.)

ROOF PLAN
EL. (+) 14.95 (TOC)

NOTES: -
1. FOR NOTES SEE THE DRAWING NUMBER 18A08-DWG-A-0002 SH-1

LEGEND: -
F.C. - FALSE CEILING
F.F. - FALSE FLOOR

TENDER PURPOSE ONLY

IFFCO PARADEEP	OWNER: IFFCO PARADEEP
PROJECT: IFFCO PARADEEP AFBC BOILER CONTROL ROOM	
TITLE: CONTROL BUILDING ROOF PLAN	



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INSTRUMENTATION		
MECHANICAL		

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- NOTES: -**
- FOR NOTES SEE THE DRAWING NUMBER 18A08-DWG-A-0002 SH-1
- REF DWGS: -**
- FOR REF. DRAWINGS SEE THE DRAWING NUMBER 18A08-DWG-A-0002 SH-1
- LEGEND: -**
- 350 THK. FIRE WALL
 - F.C. - FALSE CEILING
 - F.F. - FALSE FLOOR

TENDER PURPOSE ONLY

	OWNER: IFFCO PARADEEP
PROJECT:	IFFCO PARADEEP AFBC BOILER CONTROL ROOM
TITLE:	CONTROL BUILDING ELEVATIONS AND SECTIONS

APPROV.	MECH.	INST.	ELEC.	STRL.	ARCH.	NATURE OF REVISION & DESCRIPTION	CHECKED	DRAWN	REV.	DATE
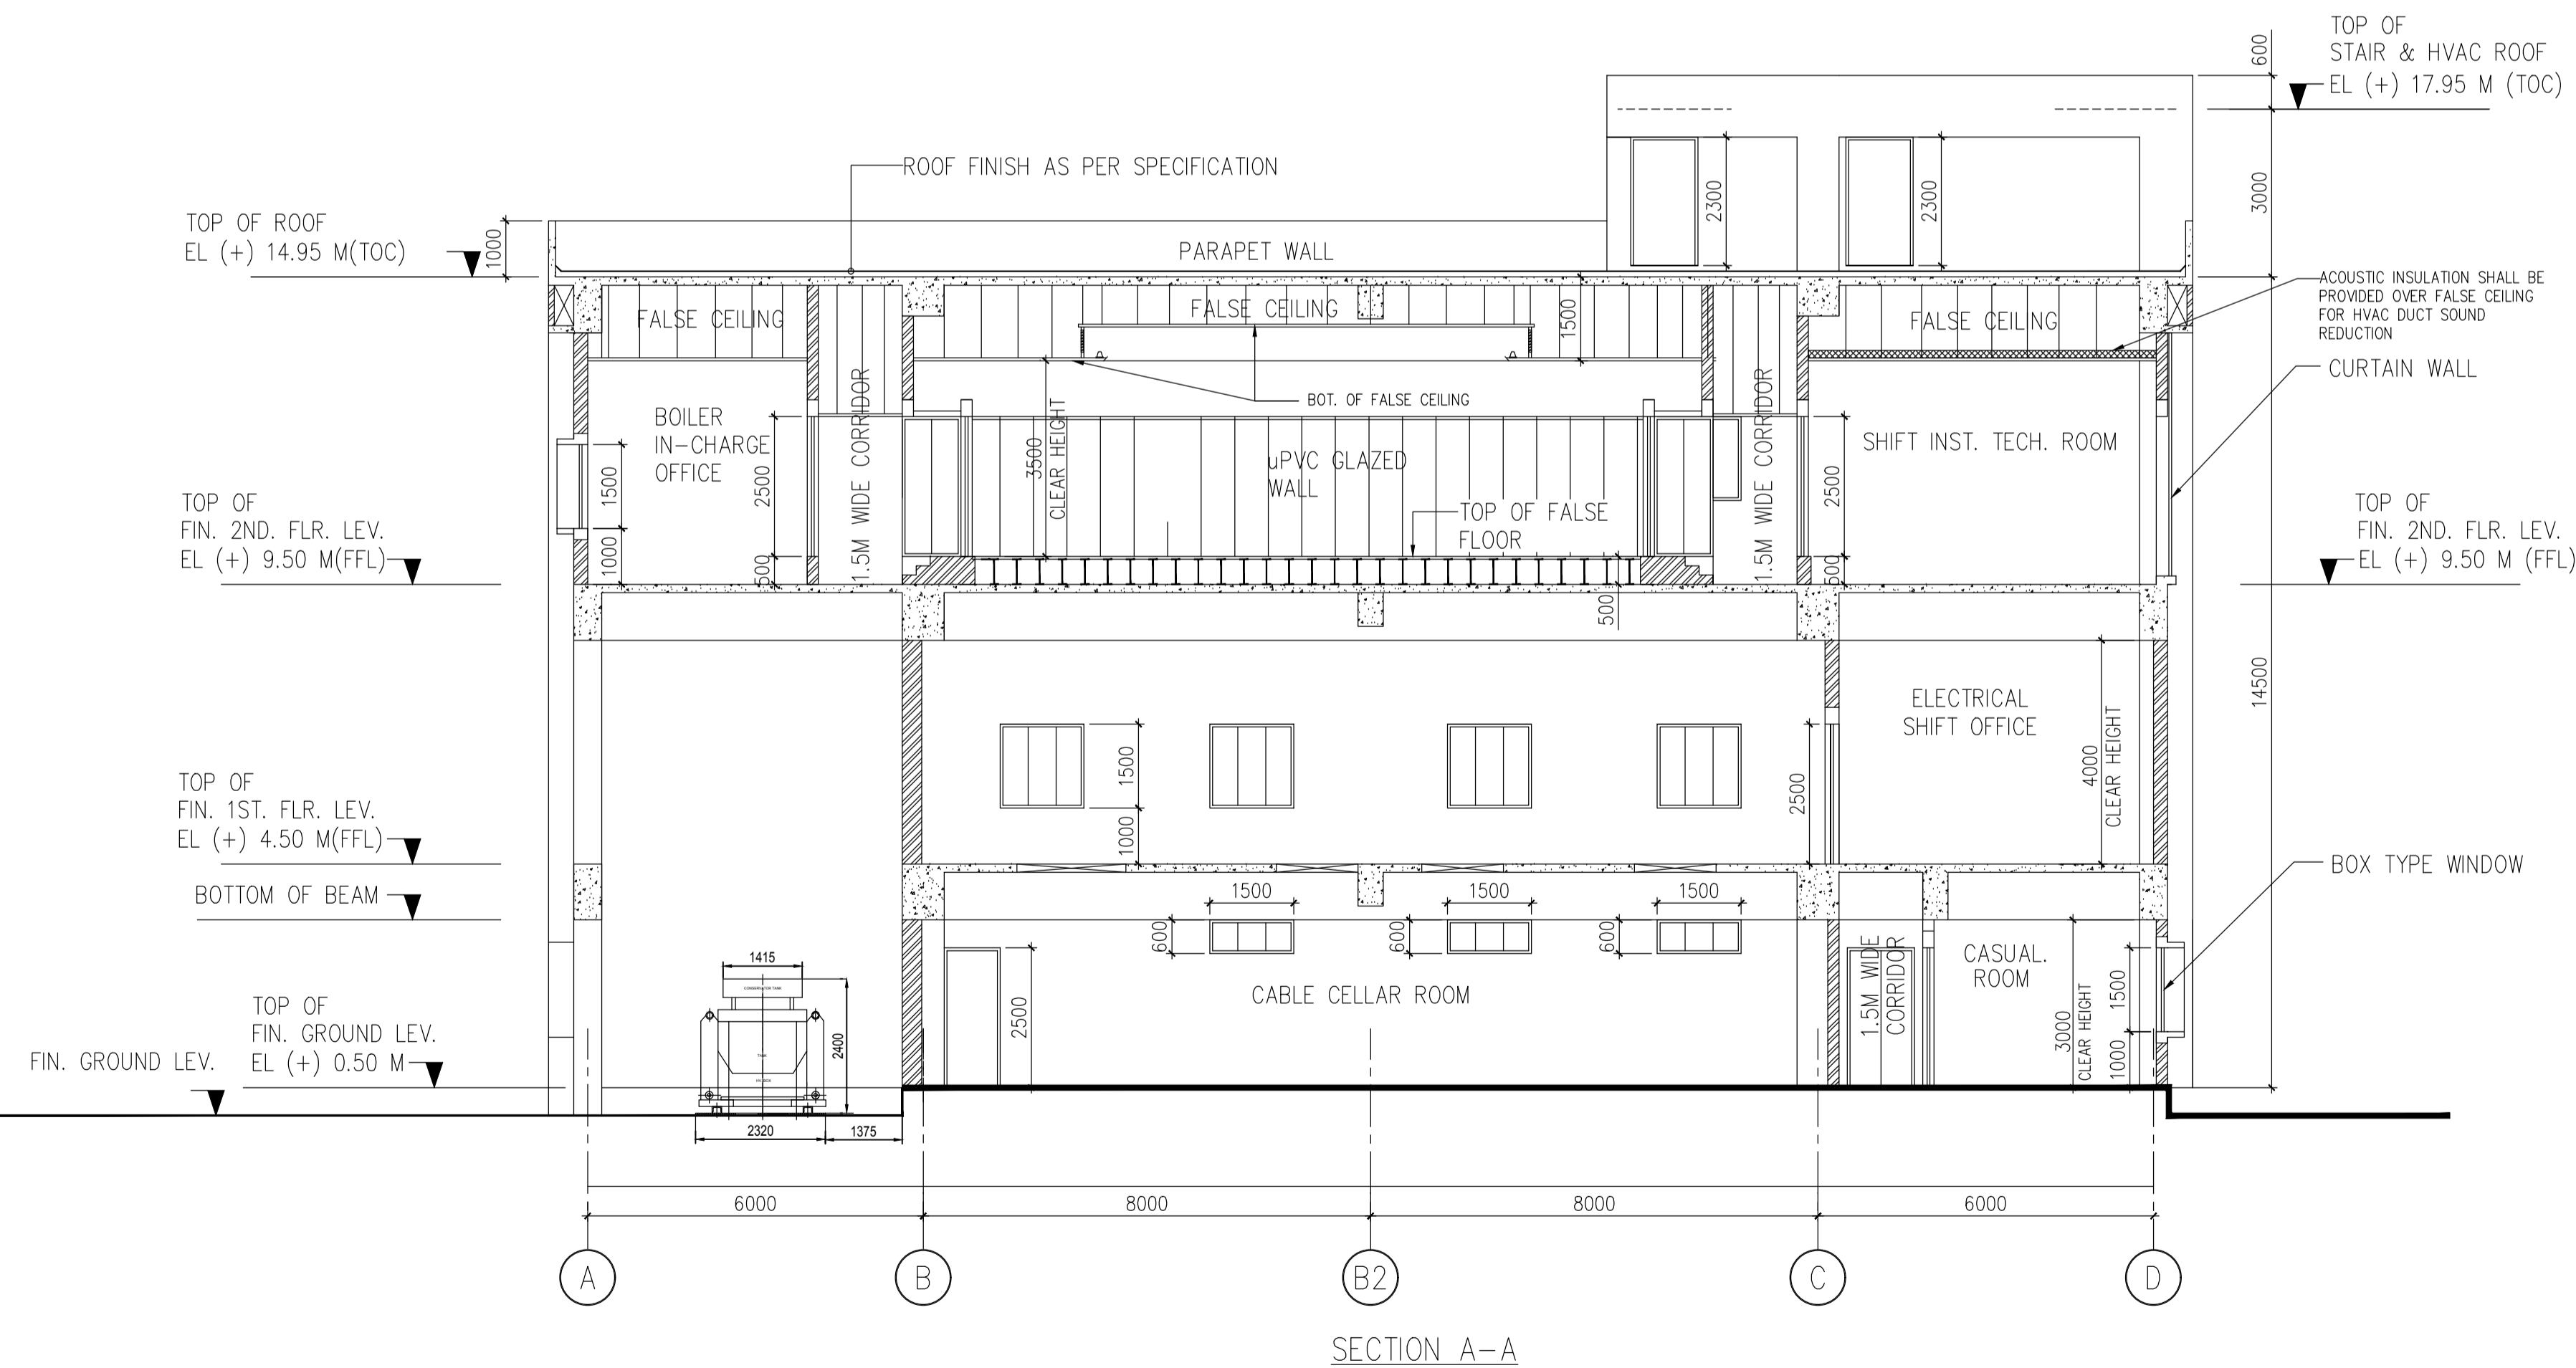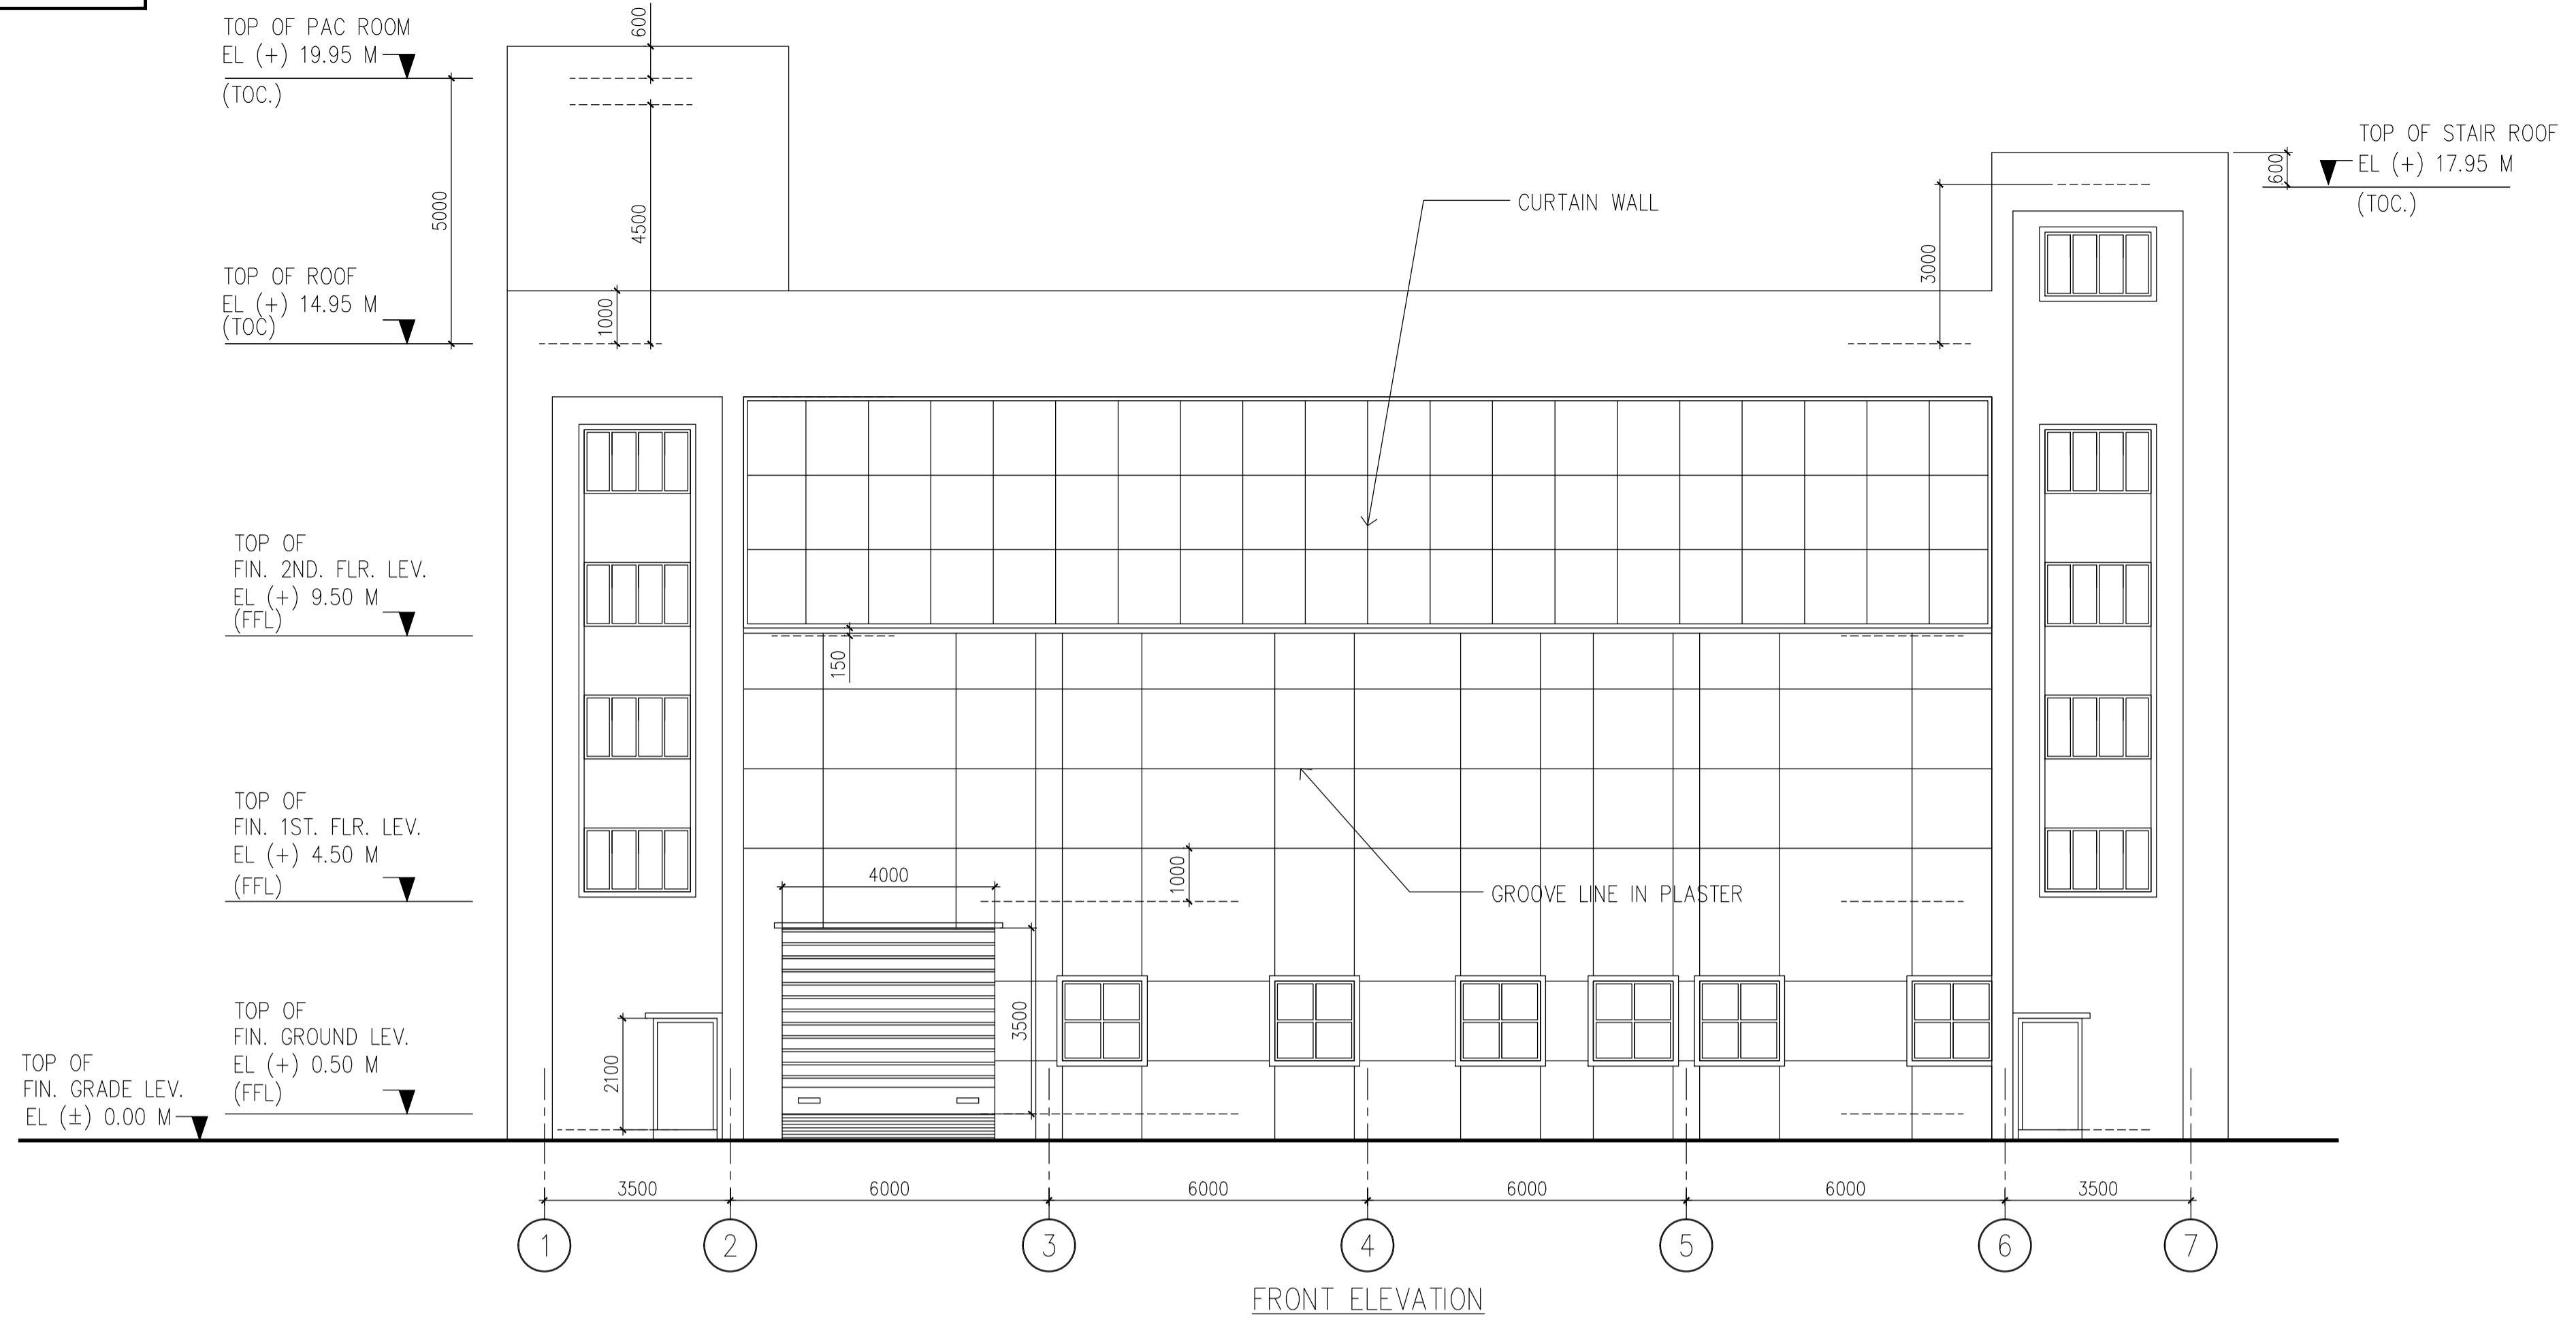
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CHECKED: SA
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JOB NO. 18A08
SCALE 1:100
DATE 22.11.2019

DWG. NO. 18A08-DWG-A-T0002

REV 0
1 SHEET OF 1

INTERIOR FINISH SCHEDULE FOR CONTROL BUILDING:

	BUILDING AREA	FLOORING	SKIRTING/DADO	WALL	CEILING	DOOR & GLAZING	WINDOW & GLAZING	REMARKS
GROUND FLOOR								
1.	CABLE CELLAR	50 MM THICK HEAVY DUTY CEMENT CONCRETE FLOOR WITH METALLIC HARDENER AND MATCHING SKIRTING	SYNTHETIC ENAMEL PAINT WITH CEMENT PUTTY UP TO 1.50MTS HEIGHT	ACRYLIC DISTEMPER	ACRYLIC DISTEMPER	FIRE DOOR	UPVC GLAZED WINDOW / VENTILATOR	
2.	MAINTENANCE ROOM AND INST. MAINTENANCE ROOM	50 MM THICK HEAVY DUTY CEMENT CONCRETE FLOOR WITH METALLIC HARDENER AND MATCHING SKIRTING	SYNTHETIC ENAMEL PAINT WITH CEMENT PUTTY UP TO 1.50MTS HEIGHT	ACRYLIC DISTEMPER	ACRYLIC DISTEMPER	SS ROLLING SHUTTER & FACTORY MADE HOLLOW METAL STEEL FLUSH DOOR.	UPVC GLAZED WINDOW / VENTILATOR	
3.	TECHNICIAN ROOM, OPERATOR ROOM AND CASUAL ROOM & CORRIDOR	10 MM THICK NON-SKID FULLY VITRIFIED TILES OF MINIMUM SIZE 600 MM X 600 MM (OVERALL 50 MM THICK) LAID IN PATTERN WITH 150MM HIGH SKIRTING.	150 MM HIGH MATCHING SKIRTING	ACRYLIC EMULSION PAINT WITH ACRYLIC WALL PUTTY.	FALSE CEILING SHALL BE OF LUXALON TYPE SS CEILING WITH SS CLIPS AND HANGERS	WPC DOOR.	UPVC GLAZED WINDOW / VENTILATOR	
4.	TOILETS, PANTRY AND WET AREAS	10 MM THICK NON-SKID FULLY VITRIFIED TILES OF MINIMUM SIZE 400 MM X 400 MM (OVERALL 40 MM THICK) LAID IN PATTERN WITH 5 MM THICK GLAZED CERAMIC TILE DADO OF SAME MAKE TOPPED WITH 50 MM WIDE MATCHING CERAMIC TRIMS. HEIGHT OF DADO SHALL BE 100MM HIGHER THAN THE LINTEL LEVEL STARTING FROM FLOOR FINISH LEVEL.	1ST QUALITY COLOURED GLAZED CERAMIC TILES OF MINIMUM 5 MM THICKNESS UP TO 100 MM HIGHER THAN LINTEL LEVEL STARTING FROM FINISH FLOOR LEVEL.	ACRYLIC EMULSION PAINT WITH ACRYLIC WALL PUTTY.	ACRYLIC DISTEMPER	WPC DOOR.	UPVC GLAZED WINDOW / VENTILATOR	
5.	STAIR	SEMI POLISHED 20 MM THICK KOTA STONE	SYNTHETIC ENAMEL PAINT UP TO 1.50 MTS HEIGHT	ACRYLIC EMULSION PAINT WITH ACRYLIC WALL PUTTY.	ACRYLIC EMULSION PAINT.	FIRE CHECK DOOR.	UPVC GLAZED WINDOW / VENTILATOR	
FIRST FLOOR								
1.	SWITCHGEAR ROOM	2MM THICK ANTISTATIC PVC FLOORING	2MM THICK ANTISTATIC PVC DADO UP TO 1.50MTS HEIGHT	ACRYLIC DISTEMPER	ACRYLIC DISTEMPER	FIRE DOOR / SS ROLLING SHUTTER	UPVC GLAZED WINDOW / VENTILATOR	
2.	ELECTRICAL ROOM	50 MM THICK HEAVY DUTY CEMENT CONCRETE FLOOR WITH METALLIC HARDENER AND MATCHING SKIRTING	SYNTHETIC ENAMEL PAINT WITH CEMENT PUTTY UP TO 1.50MTS HEIGHT	ACRYLIC DISTEMPER	ACRYLIC DISTEMPER	FIRE DOOR	UPVC GLAZED WINDOW / VENTILATOR	
3.	PLC ROOM AND ELECTRICAL SHIFT OFFICE	10/11 MM THICK NON-SKID FULLY VITRIFIED TILES OF MINIMUM SIZE 600 MM X 600 MM (OVERALL 50 MM THICK) LAID IN PATTERN WITH 150MM HIGH SKIRTING.	150 MM HIGH MATCHING SKIRTING	ACRYLIC EMULSION PAINT WITH ACRYLIC WALL PUTTY.	FALSE CEILING SHALL BE OF LUXALON TYPE SS CEILING WITH SS CLIPS AND HANGERS	FIRE DOOR.	UPVC GLAZED WINDOW / VENTILATOR	
4.	TOILETS, PANTRY AND WET AREAS	10 MM THICK NON-SKID FULLY VITRIFIED TILES OF MINIMUM SIZE 400 MM X 400 MM (OVERALL 40 MM THICK) LAID IN PATTERN WITH 5 MM THICK GLAZED CERAMIC TILE DADO OF SAME MAKE TOPPED WITH 50 MM WIDE MATCHING CERAMIC TRIMS. HEIGHT OF DADO SHALL BE 100MM HIGHER THAN THE LINTEL LEVEL STARTING FROM FLOOR FINISH LEVEL.	1ST QUALITY COLOURED GLAZED CERAMIC TILES OF MINIMUM 5 MM THICKNESS UP TO 100 MM HIGHER THAN LINTEL LEVEL STARTING FROM FINISH FLOOR LEVEL.	ACRYLIC EMULSION PAINT WITH ACRYLIC WALL PUTTY.	ACRYLIC DISTEMPER	WPC DOOR.	UPVC GLAZED WINDOW / VENTILATOR	
5.	STAIR	SEMI POLISHED 20 MM THICK KOTA STONE	SYNTHETIC ENAMEL PAINT UP TO 1.50 MTS HEIGHT	ACRYLIC EMULSION PAINT WITH ACRYLIC WALL PUTTY.	ACRYLIC EMULSION PAINT.	FIRE CHECK DOOR.	UPVC GLAZED WINDOW / VENTILATOR	
SECOND FLOOR								
1.	OFFICES, SHIFT INST. TECH. ROOM & RECORD ROOM	10/11 MM THICK NON-SKID FULLY VITRIFIED TILES OF MINIMUM SIZE 600 MM X 600 MM (OVERALL 50 MM THICK) LAID IN PATTERN WITH 150MM HIGH SKIRTING.	150 MM HIGH MATCHING SKIRTING	ACRYLIC EMULSION PAINT WITH ACRYLIC WALL PUTTY.	FALSE CEILING SHALL BE OF LUXALON TYPE SS CEILING WITH SS CLIPS AND HANGERS	UPVC GLAZED PARTITION DOOR	UPVC GLAZED WINDOW / VENTILATOR	
2.	DCS CONTROL ROOM & DCS MARSHALLING ROOM	STEEL PANELLED ACCESS FLOORING WITH 2MM ANTISTATIC PVC TILES ON TOP	ANTISTATIC PVC SKIRTING 150MM HIGH.	UPVC GLAZED PARTITION & ACRYLIC EMULSION PAINT WITH ACRYLIC WALL PUTTY.	FALSE CEILING SHALL BE OF LUXALON TYPE SS CEILING WITH SS CLIPS AND HANGERS	UPVC GLAZED PARTITION DOOR	UPVC GLAZED WINDOW / VENTILATOR	
3.	TOILETS, PANTRY AND WET AREAS	10 MM THICK NON-SKID FULLY VITRIFIED TILES OF MINIMUM SIZE 400 MM X 400 MM (OVERALL 40 MM THICK) LAID IN PATTERN WITH 5 MM THICK GLAZED CERAMIC TILE DADO OF SAME MAKE TOPPED WITH 50 MM WIDE MATCHING CERAMIC TRIMS. HEIGHT OF DADO SHALL BE 100MM HIGHER THAN THE LINTEL LEVEL STARTING FROM FLOOR FINISH LEVEL.	1ST QUALITY COLOURED GLAZED CERAMIC TILES OF MINIMUM 5 MM THICKNESS UP TO 100 MM HIGHER THAN LINTEL LEVEL STARTING FROM FINISH FLOOR LEVEL.	ACRYLIC EMULSION PAINT WITH ACRYLIC WALL PUTTY.	ACRYLIC DISTEMPER	WPC DOOR.	UPVC GLAZED WINDOW / VENTILATOR	
5.	CORRIDOR	10/11 MM THICK NON-SKID FULLY VITRIFIED TILES OF MINIMUM SIZE 600 MM X 600 MM (OVERALL 50 MM THICK) LAID IN PATTERN WITH 150MM HIGH SKIRTING.	150 MM HIGH MATCHING SKIRTING	UPVC GLAZED PARTITION & ACRYLIC EMULSION PAINT WITH ACRYLIC WALL PUTTY.	FALSE CEILING SHALL BE OF LUXALON TYPE SS CEILING WITH SS CLIPS AND HANGERS	UPVC GLAZED PARTITION DOOR	UPVC GLAZED WINDOW / VENTILATOR	
5.	STAIR	SEMI POLISHED 20 MM THICK KOTA STONE	SYNTHETIC ENAMEL PAINT UP TO 1.50 MTS HEIGHT	ACRYLIC EMULSION PAINT WITH ACRYLIC WALL PUTTY.	ACRYLIC EMULSION PAINT.	FIRE CHECK DOOR.	UPVC GLAZED WINDOW / VENTILATOR	
ROOF LEVEL								
	ROOF	ROOF FINISH SHALL BE PROVIDED WITH 3 LAYERS, FIRST BEING ELASTOMERIC MEMBRANE WATER PROOFING TREATMENT, SECONDLY SCREED CONCRETE SHALL BE LAID AND FINALLY THE WEARING COURSE. 1.5MM THICK ELASTOMERIC MEMBRANE SHALL BE LAID AS PER MANUFACTURER'S SPECIFICATION. RUN OFF GRADIENT SHALL BE GIVEN A MINIMUM OF 1 IN 100. GRADIENT SHALL COMPRISE SCREED CONCRETE 1:2:4 USING 12.5 MM OR BELOW COARSE AGGREGATE. OVER THE SCREED CONCRETE WEARING COURSE TREATMENT SHALL BE PROVIDED AS BELOW: A WEARING COURSE SHALL CONSIST OF PRESSED CLAY TILES OF SIZE 230X230X18 MM LAID IN WATER PROOFING COMPOUND MIXED CEMENT MORTAR (1:3) AND SEALING OF JOINTS USING SEALING COMPOUND						

NOTES: -

1. FOR NOTES SEE THE DRAWING NUMBER 18A08-DWG-A-0002 SH-1

REF DWGS: -

1. FOR REF. DRAWINGS SEE THE DRAWING NUMBER 18A08-DWG-A-0002 SH-1

TENDER PURPOSE ONLY

IFFCO PARADEEP OWNER: IFFCO PARADEEP

PROJECT: IFFCO PARADEEP AFBC BOILER CONTROL ROOM

TITLE: CONTROL BUILDING FINISH SCHEDULE

DEVELOPMENT CONSULTANTS PVT LTD. CONSULTING ENGINEERS KOLKATA • MUMBAI • CHENNAI • NEW DELHI

PREPARED SM JOB NO. 18A08
 CHECKED SA SCALE AS NOTED
 APPROVED PKP DATE 22.11.2019

DWG. NO. 18A08-DWG-A-T0003 REV 0 1 SHEET OF 1

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DOOR & ROLLING SHUTTER SCHEDULE FOR CONTROL BUILDING:

DOOR MARKED	DOOR MARKED	QUANTITY	DESCRIPTION	MASONRY OPENING(MM)		DOOR SIZE(MM)		MATERIAL		GLASS	HARDWARE SET	REMARKS
				WIDTH	HEIGHT	WIDTH	HEIGHT	FRAME	SHUTTER			
SD1	A	03	SINGLE LEAF HOLLOW METAL PRESSED STEEL DOOR WITH VISION PANEL 150X250	1000	2500	980	2490	PRESSED STEEL	PRESSED STEEL	6 MM GLASS	SET 1	
SD2	B	02	SINGLE LEAF HOLLOW METAL PRESSED STEEL DOOR WITH VISION PANEL 150X250	1200	2100	1180	2090	PRESSED STEEL	PRESSED STEEL	6 MM GLASS	SET 2	
SD3	C	03	SINGLE LEAF HOLLOW METAL PRESSED STEEL DOOR	1200	2300	1180	2290	PRESSED STEEL	PRESSED STEEL	-	SET 3	DOOR AT ROOF LEVEL
FD1	E	10	DOUBLE LEAF 2 HR RATED FIRE CHECK DOOR	1200	2500	1180	2490	PRESSED STEEL	PRESSED STEEL	AS PER VENDOR	SET 5	WITH PANIC BAR & VISION PANEL
FD2	D	02	SINGLE LEAF 2 HR RATED FIRE CHECK DOOR	1000	2500	980	2490	PRESSED STEEL	PRESSED STEEL	AS PER VENDOR	SET 4	WITH PANIC BAR & VISION PANEL
FD3	D	03	SINGLE LEAF 2 HR RATED FIRE CHECK DOOR	1200	2500	1180	2490	PRESSED STEEL	PRESSED STEEL	AS PER VENDOR	SET 4	WITH PANIC BAR & VISION PANEL
FD4	E	01	DOUBLE LEAF 2 HR RATED FIRE CHECK DOOR	1500	2500	1480	2490	PRESSED STEEL	PRESSED STEEL	AS PER VENDOR	SET 5	WITH PANIC BAR & VISION PANEL
WPC1	F	09	SINGLE LEAF WOOD PLASTIC COMPOSITE DOOR	1000	2100	980	2090	WOOD PLASTIC	WOOD PLASTIC	-	SET 6	WITH VISION PANEL
WPC2	G	09	SINGLE LEAF WOOD PLASTIC COMPOSITE DOOR	800	2100	780	2090	WOOD PLASTIC	WOOD PLASTIC	-	SET 7	TOILET AND PANTRY DOOR
RS1	-	01	STEEL ROLLING SHUTTER (MECHANICALLY OPERATED)	4000	3500	-	-	-	-	-	-	AS PER MANUFACTURER'S DETAIL
RS2	-	02	STEEL ROLLING SHUTTER (MECHANICALLY OPERATED)	2500	3500	-	-	-	-	-	-	AS PER MANUFACTURER'S DETAIL

WINDOW SCHEDULE FOR CONTROL BUILDING:

WINDOW MARKED	QUANTITY	DESCRIPTION	MASONRY OPENING(MM)		WINDOW SIZE(MM)		MATERIAL		GLASS	REMARKS
			WIDTH	HEIGHT	WIDTH	HEIGHT	FRAME	SHUTTER		
W1	09	UPVC FIXED GLAZED WINDOW	2000	1500	1980	1480	UPVC	GLASS	4.0MM THICK CLEAR TOUGHENED GLASS	DETAILS AS PER MANUFACTURER
W2	04	UPVC GLAZED SLIDING WINDOW	3000	1500	2980	1480	UPVC	GLASS	4.0MM THICK CLEAR TOUGHENED GLASS	
W3	19	UPVC GLAZED CASEMENT WINDOW	1500	1500	1480	1480	UPVC	GLASS	4.0MM THICK CLEAR TOUGHENED GLASS	
W4	01	UPVC GLAZED CASEMENT WINDOW	1000	1500	980	1480	UPVC	GLASS	4.0MM THICK CLEAR TOUGHENED GLASS	
V1	06	UPVC LOUVER	1500	600	1480	580	UPVC	GLASS	6.0MM THICK CLEAR WIRED GLASS	
V2	03	UPVC LOUVER	1900	600	1880	580	UPVC	GLASS	6.0MM THICK CLEAR WIRED GLASS	
V3	08	UPVC LOUVER	1275	600	1255	580	UPVC	GLASS	6.0MM THICK CLEAR WIRED GLASS	

NOTES: -

1. FOR NOTES SEE THE DRAWING NUMBER 18A08-DWG-A-0002 SH-1

REF DWGS: -

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TENDER PURPOSE ONLY

	OWNER: IFFCO PARADEEP
PROJECT: IFFCO PARADEEP AFBC BOILER CONTROL ROOM	
TITLE: CONTROL BUILDING DOOR, WINDOW AND ROLLING SHUTTER SCHEDULE	

DEVELOPMENT CONSULTANTS PVT LTD. CONSULTING ENGINEERS KOLKATA • MUMBAI • CHENNAI • NEW DELHI

PREPARED SM	JOB NO. 18A08	
CHECKED SA	SCALE AS NOTED	
APPROVED PKP	DATE 22.11.2019	REV 0
DWG. NO. 18A08-DWG-A-T0004		1 SHEET OF 1

APPROV.	MECH.	INST.	ELEC.	STR.	ARCH.	NATURE OF REVISION & DESCRIPTION	CHECKED	DRAWN	REV.	DATE	RELEASE STATUS	DATE	SIGNATURE
											FOR TENDER ONLY	29.11.19	PKP
											FOR CONSTRUCTION		
											ARCHITECTURAL	29.11.19	PKP
											CIVIL & STRUCTURAL		
											ELECTRICAL		
											INSTRUMENTATION		
											MECHANICAL		